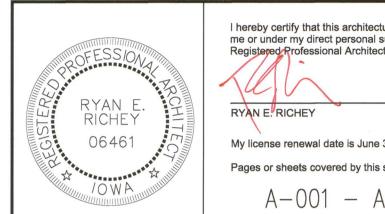
IOWA DEPARTMENT OF NATURAL RESOURCES

CONSTRUCTION DOCUMENTS FOR LAKE AHQUABI STATE PARK BOAT STORAGE BUILDING WARREN COUNTY, IOWA



me or under my direct personal supervision and that I am a duly

A-001 - A-600

SHEET. NO. SHEET TITLE COVER SHEET WALL TYPES, NOTES AND SYMBOLS ARCHITECTURAL SITE PLAN LIFE SAFETY PLAN REFERENCE FLOOR PLAN REFLECTED CEILING AND POWER PLAN BUILDING ELEVATIONS BUILDING SECTIONS FINISH AND DOOR SCHEDULES

BID ITEMS

ITEM DESCRIPTION

3 SITE ELECTRICAL (DISTRIBUTION PANEL, METERS & SERVICE LINES)

NUMBER

1 GRADING

5 MOBILIZATION

2 SEEDING, FERTILIZING AND FINISHING

4 STORAGE BUILDING (ALL COMPONENTS)

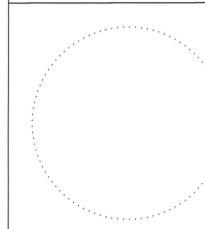
CONSTRUCTION STAKING

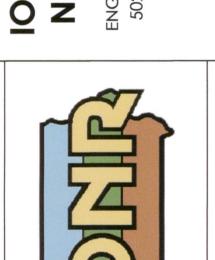
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NO. DATE REVISION

03.01.2017 A-001



PROJECT #17-05-91-03

PLANS PREPARED BY LAND AND WATERS BUREAU CONSERVATION AND RECREATION DIVISION

	DIREC	TORY		
OWNER		DISTRICT INSPECTOR		
COMPANY	IOWA DEPARTMENT OF NATURAL RESOURCES	COMPANY	IOWA DEPARTMENT OF NATURAL RESOURCES	
ADDRESS	502 E. 9TH. ST.	ADDRESS		
CITY,STATE,ZIP	DES MOINES, IA 50319	CITY,STATE,ZIP	INDIANOLA, IA	
CONTACT	N/A	CONTACT	JASON KRUSE	
TELEPHONE	515.725.8200	TELEPHONE	515-250-3707	
FAX	515.725.8202	FAX	-	
EMAIL	N/A	EMAIL	JASON.KRUSE@DNR.IOWA.GOV	
ARCHITECT				
COMPANY	IOWA DEPARTMENT OF NATURAL RESOURCES		-	
ADDRESS	502 E. 9TH. ST.		-	
CITY,STATE,ZIP	DES MOINES, IA 50319		-	
CONTACT	RYAN RICHEY		-	
TELEPHONE	515.979.0107		-	
FAX	-		-	
EMAIL	RYAN.RICHEY@DNR.IOWA.GOV		-	
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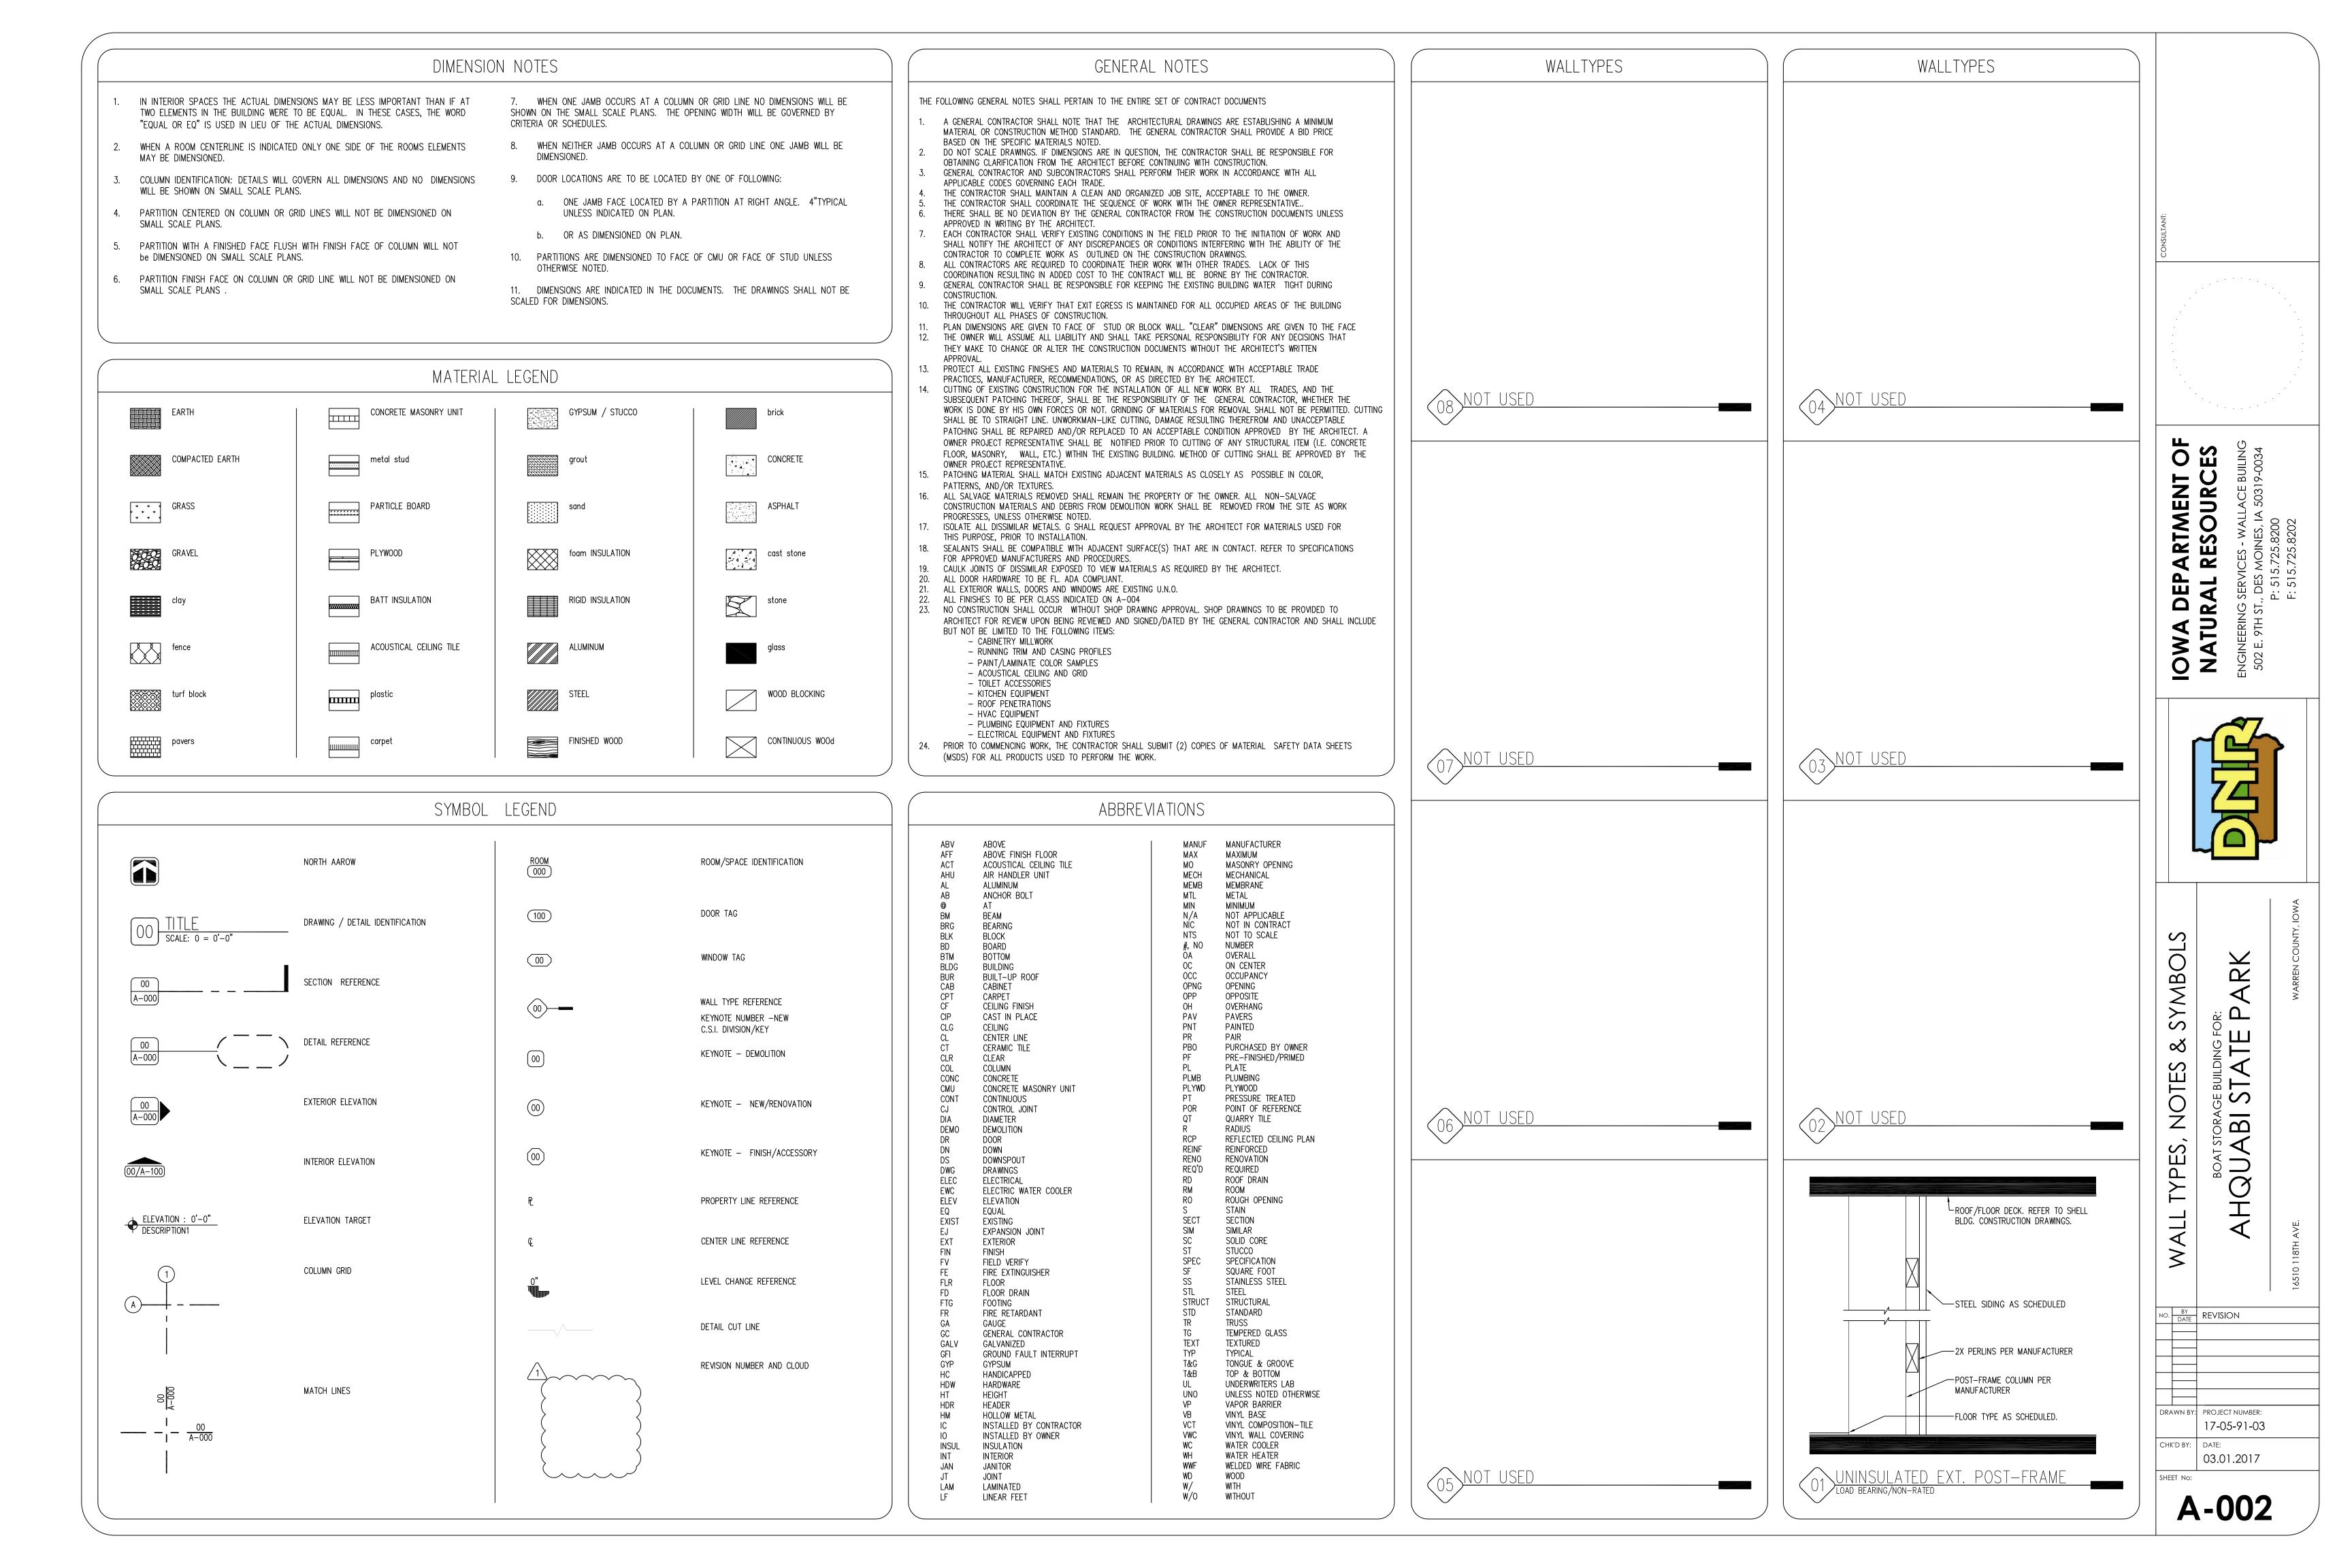
PROJECT DATA	BUILDING DATA	BUILDING CODES
OCCUPANT LOAD: GROUP S-1 - STORAGE / ACCESSORY STORAGE AREAS - 1,400 GROSS (IBC TABLE 1004.1.1) STORAGE 1,400 SF / 300 = 4.67 = 5 OCCUPANTS TOTAL OCCUPANT LOAD = 5 OCCUPANTS REQUIRED FIXTURES: 0 TOTAL WATER CLOSETS	MEANS OF EGRESS: MIN. REQ-D # EXITS = 2 EXITS PER LEVEL (IBC TABLE 1021.1) MAX TRAVEL DISTANCE = 200' (IBC 1016.1) DEAD-END CORRIDOR = 20' MAX (IBC 1018.4) MIN. CORRIDOR WIDTH = 36" CLEAR MIN. CLEAR OPENINGS FOR EXIT DOORS = 32" (ACTUAL 34") FIRE EXTINGUISHERS: THE NUMBER AND LOCATIONS OF FIRE EXTINGUISHERS TO BE DETERMINED BY THE FIRE MARSHAL PRIOR TO CERTIFICATE OF OCCUPANCY. BUILDING: ADDRESS: LAKE AHQUABI STATE PARK 16510 118TH AVENUE INDIANOLA, IA 50125 WARREN COUNTRY USE - STORAGE BUILDING CONSTRUCTION - TYPE V-b (W/OUT AUTOMATIC SPRINKLER SYSTEM) NUMBER OF STORIES - 1 STORY BUILDING HEIGHT - 18'-4" BUILDING AREA - 1,400 GSF BUILDING OCCUPANCY - GROUP S-1, STORAGE	BUILDING CODE — 2015 INTERNATIONAL BUILDING CODE STRUCTURAL CODE — 2015 INTERNATIONAL BUILDING CODE PLUMBING CODE — 2012 UNIFORM PLUMBING CODE & IOWA ADMINISTRATIVE CODE 641—25 MECHANICAL CODE — 2012 INTERNATIONAL MECHANICAL CODE ELECTRICAL CODE — 2014 NATIONAL ELECTRIC CODE ENERGY CODE — 2012 INTERNATIONAL ENERGY CONSERVATION CODE ACCESSIBILITY CODE — 2010 ADA STANDARDS — US DEPARTMENT OF JUSTICE

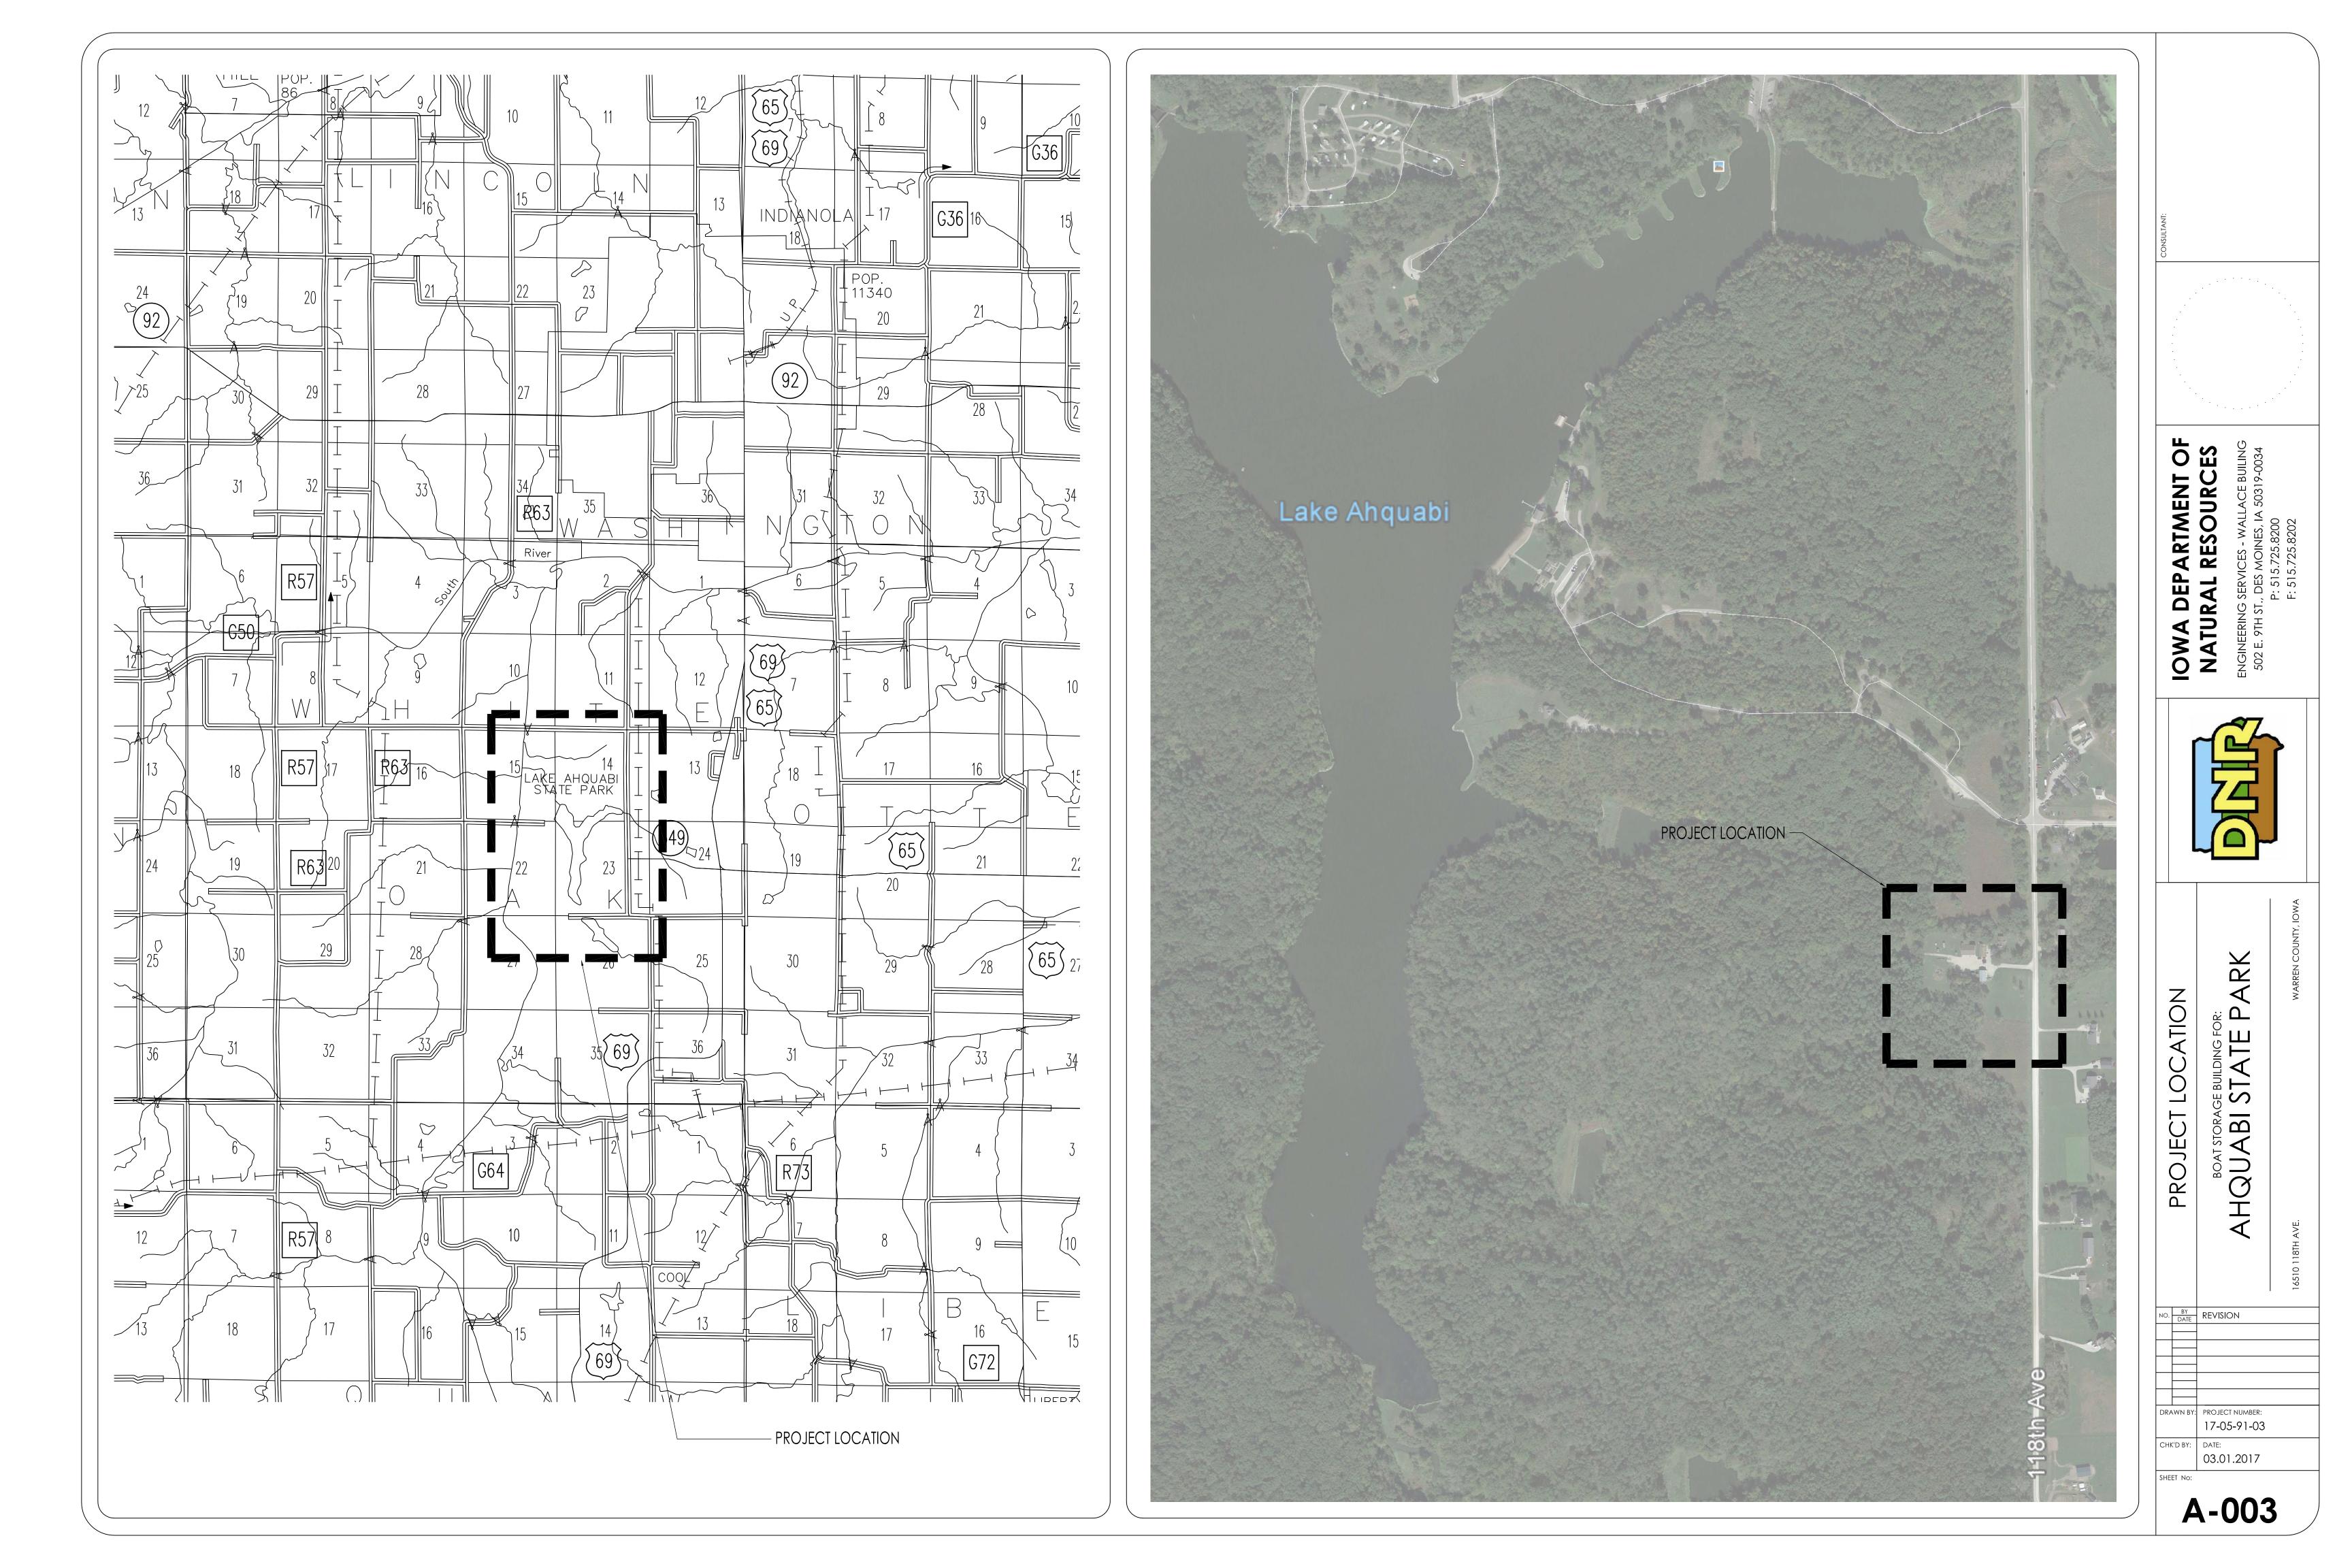
CURRENTLY THERE IS NOT AN ADEQUATE STORAGE FACILITY AT LAKE AHQUABI FOR LAW ENFORCEMENT BOATS. THIS NEW STORAGE FACILITY WILL PROVIDE STORAGE FOR MULTIPLE BOATS AND ALLOW LAW ENFORCEMENT TO ACCESS LOCAL AREAS MORE EASILY. THE PROPOSED STORAGE BUILDING WILL HAVE 10'-0" OVERHEAD DOORS, LED LIGHTING AND ELECTRICAL POWER.

PROJECT DESCRIPTION

3/2/19 mr P An 3-2-2017

AUTHORIZATION TO BID







KEYNOTES GENERAL NOTES 1. PROPOSED STORAGE BUILDING, ADD ±6" TO EXISTING GRADE FOR BUILDING SLAB ELEVATION. REAR OF BUILDING TO BE EVEN WITH REAR OF THE ADJACENT BUILDING.

14. QUARTZITE HANDHOLE WITH COVER, COORDINATE LOCATION. SPLICE AND CONNECT EXISTING FEEDERS AND GROUND WIRE, EXTEND IF NECESSARY. A. REFER TO FINISH & DOOR SCHEDULE, SHEET A-600. B. ALL ELECTRICAL SHALL BE NEC COMPLIANT AND UP TO ALL CODES AND ORDINANCES REQUIRED BY 2. EXISTING BUILDING TO REMAIN. LAW. ALL OUTLETS TO BE MOUNTED AT 42" A.F.F. 3. NEW ELECTRICAL SERVICE TO BUILDING, CONTRACTOR TO DETERMINE WHAT IS TO BE PROVIDED. C. REFER TO INDEX SHEET FOR WALL TYPES, SHEET A-002. D. FIELD VERIFY ALL DIMENSIONS PRIOR TO CONSTRUCTION, A-100.
E. FIELD VERIFY EQUIPMENT LOCATIONS FOR ELECTRICAL OUTLET LOCATIONS. REFER TO ELECTRICAL 4. CLASS "A" ROAD STONE DRIVE, ENTIRE FRONT OF BUILDING, FROM THE EDGE OF BUILDING SLAB TO THE EXISTING ROCKED ROAD. 5. EXISTING ROCKED ROAD/YARD TO REMAIN. REFER TO FINISH SCHEDULE SHEET FOR COLOR AND MATERIAL SECTIONS, SHEET A-600. 6. EXISTING LIME KILN TO REMAIN. G. CONTRACTOR TO HAVE THIS BUILDING, PRIOR TO CONSTRUCTION, PRE-ENGINEERED BY BUILDING 7. EXISTING WEATHER STATION TO REMAIN. 8. EXISTING POWER POLE TO REMAIN, SERVICE POWER TO BE REWORKED. RUN DOWN POLE TO PAD MOUNTED TRANSFORMER. COORDINATE REQUIREMENTS FOR NEW TRANSFORMER AND ROUTING PRIMARY FEEDERS WITH UTILITY COMPANY. 9. 600 AMP SQUARE D DISTRIBUTION PANEL WITH NEMA 3R ENCLOSURE OR EQUAL. ONE METER FOR HOUSE AND ONE METER FOR THE REST OF THE SITE. FIELD VERIFY AMPERAGE AND DISTRIBUTION PANEL SIZING. ALL EQUIPMENT MOUNTED ON UNISTRUT H-FRAMEWORK. EMBED UNISTRUT IN CONCRETE FOUNDATION AT EACH VERTICAL SUPPORT. 10. EXISTING UNDERGROUND FEEDERS TO EXISTING BUILDING. COORDINATE ROUTING AND INSTALL.

11. NEW ELECTRICAL LINES IN CONDUIT TO HANDHOLE. CONTRACTOR TO DETERMINE WHAT IS TO BE 12. NEW PAD MOUNTED TRANSFORMER. COORDINATE WITH UTILITY COMPANY. 13. EXISTING POWER POLE TO BE REMOVED.

ORA M

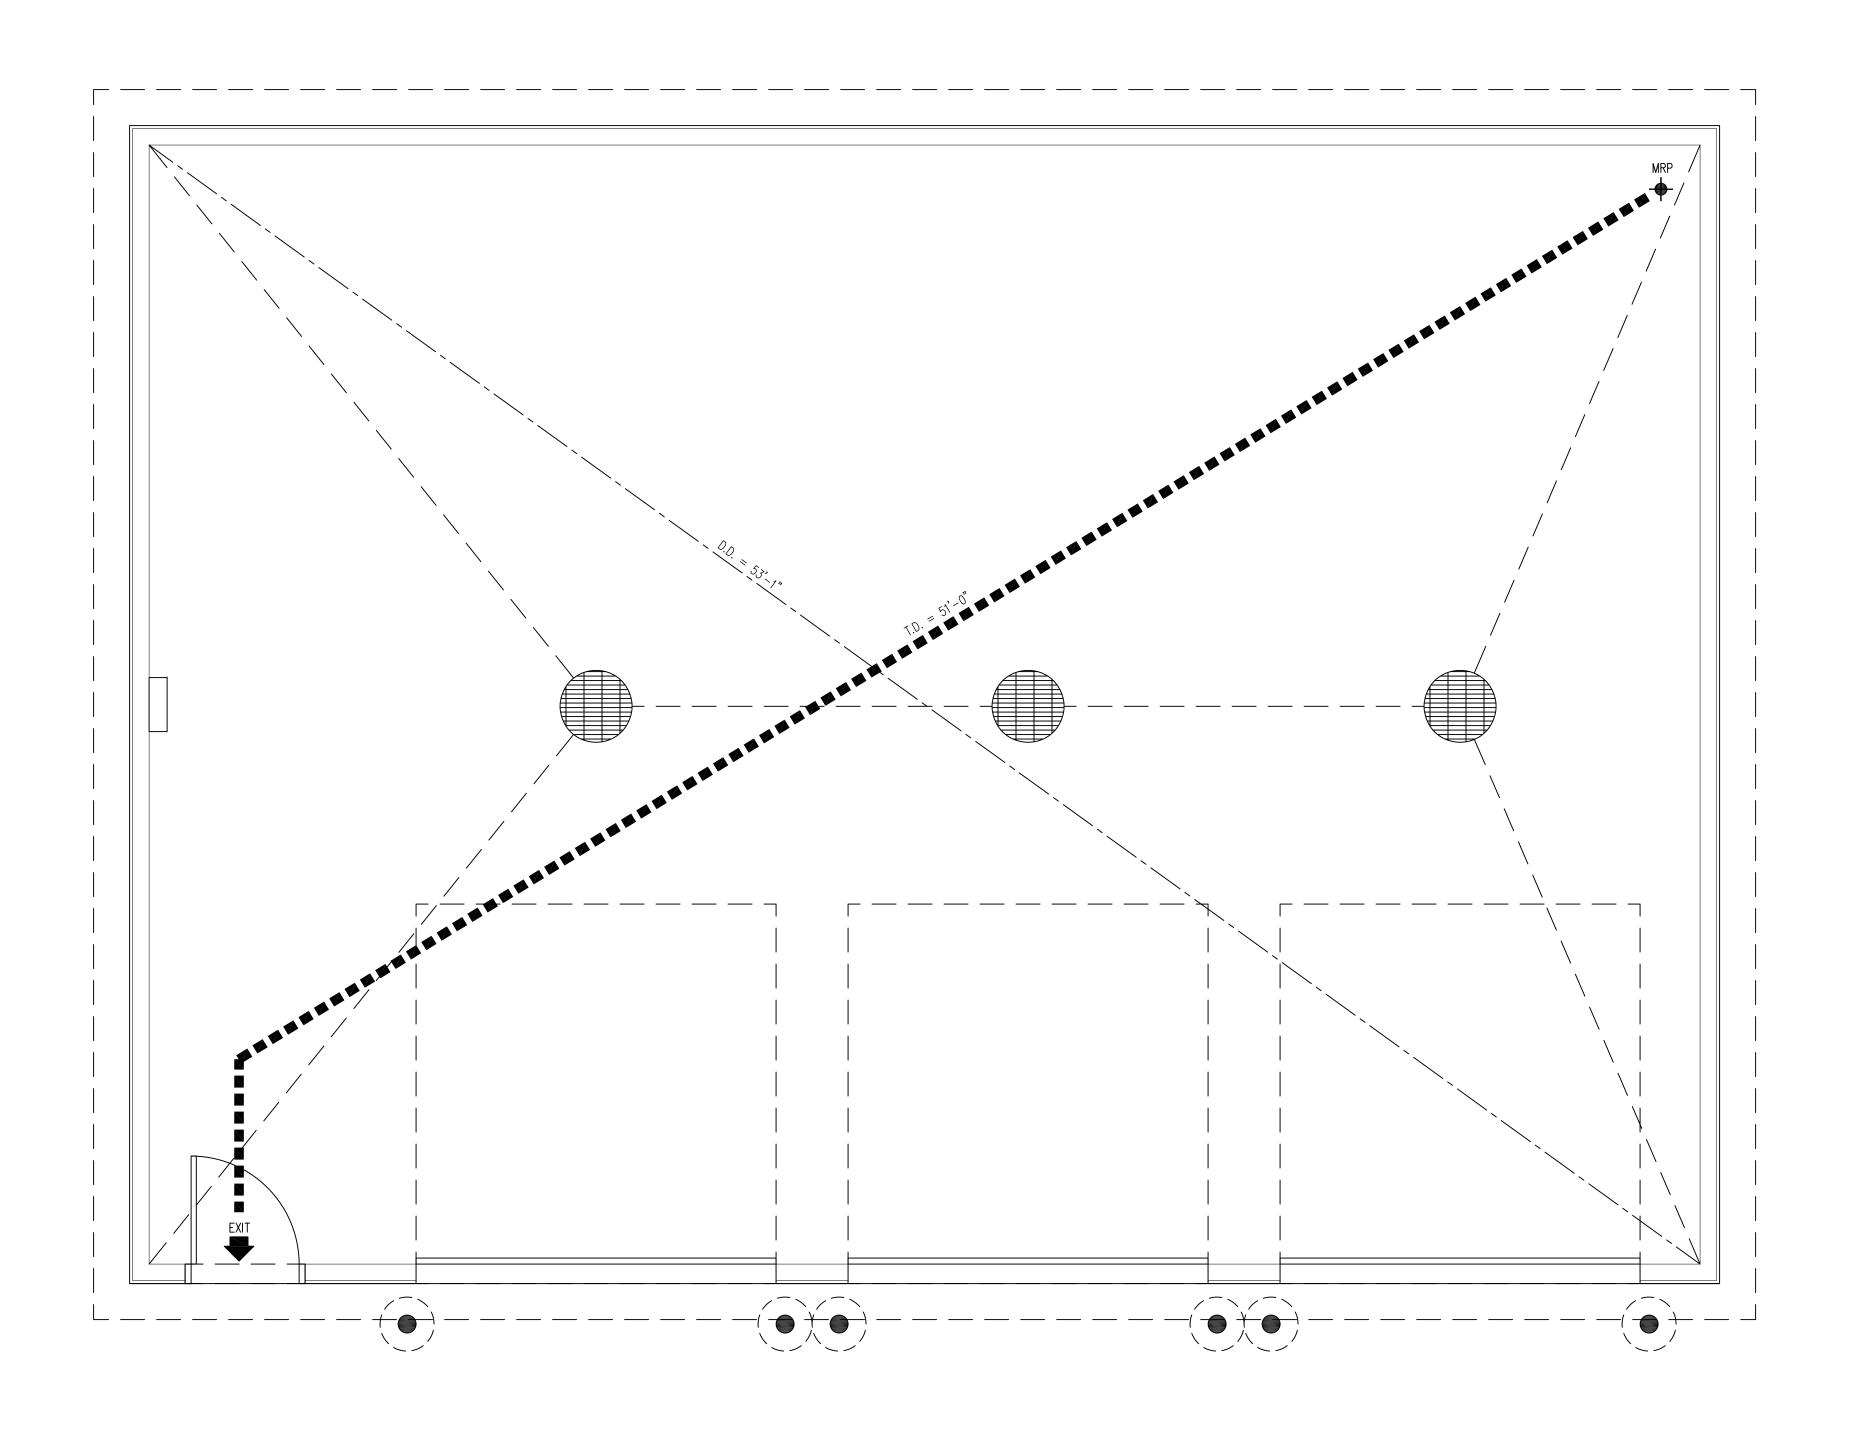
SITE

ARCHITECTUR

NO. BY REVISION

DRAWN BY: PROJECT NUMBER: 17-05-91-03

CHK'D BY: DATE: 03.01.2017



O1 LIFE SAFETY PLAN

SCALE: 3/8" = 1'-0"

	CODE SUMMARY		LIFE SAFETY LEGEND		GENERAL NOTES		
BUILDING AREA 1,400 GSF		REQUIRED	PROVIDED	SYMBOL DESCRIPTION	LINE TYPE	INTERPRETATION PROMPER ON THE LIFE CAPETY READ THE TEST SERVICE.	
	ALLOWABLE BLDG AREA (IBC TBL 503)	17,500 SF	1,400 SF	D.E. EXIT TO EXIT IN LINEAR FEET		a. INFORMATION PROVIDED ON THE LIFE SAFETY PLAN INDICATES EGRESS REQUIREMENTS.	
CONSTRUCTION TYPE V-B WITHOUT SPRINKLER SYSTEM OCCUPANCY GROUP S-1 - STORAGE		2 STORIES (40')	1 CTODICC (10')	T.D. TRAVEL DISTANCE FROM M.R.P.		b. ALL CODE REFERENCES ARE FROM INTERNATIONAL BUILDING CODE, W/ AMENDMENTS UNLESS OTHERWISE NOTED	
OROGI 3 I STORAGE	HEIGHT LIMITATION (IBC TBL 503)	2 STURIES (40)	1 STORIES (18')	D.D. DIAGONAL DISTANCE			
	AUTOMATIC SPRINKLER	NO	NO	EXIT LIGHT			
	SYSTEM (NFPA 13)				M.R.P. MOST REMOTE POINT	+	
	EXIT ACCESS TRAVEL DISTANCE (IBC 1016.1)	200'-0"	51'-0"	EXIT / ENTRY			
	EXIT ACCESS DOORWAYS (IBC TBL 1019.1)	2	1	- FEC - FIRE EXTINGUISHER			
	EGRESS WIDTH PER OCCUPANT (IBC TBL 1005.1) LEVEL [.2"]	(.2") X 5 = 1.0"	1 DOORS @ 36"= 36"				



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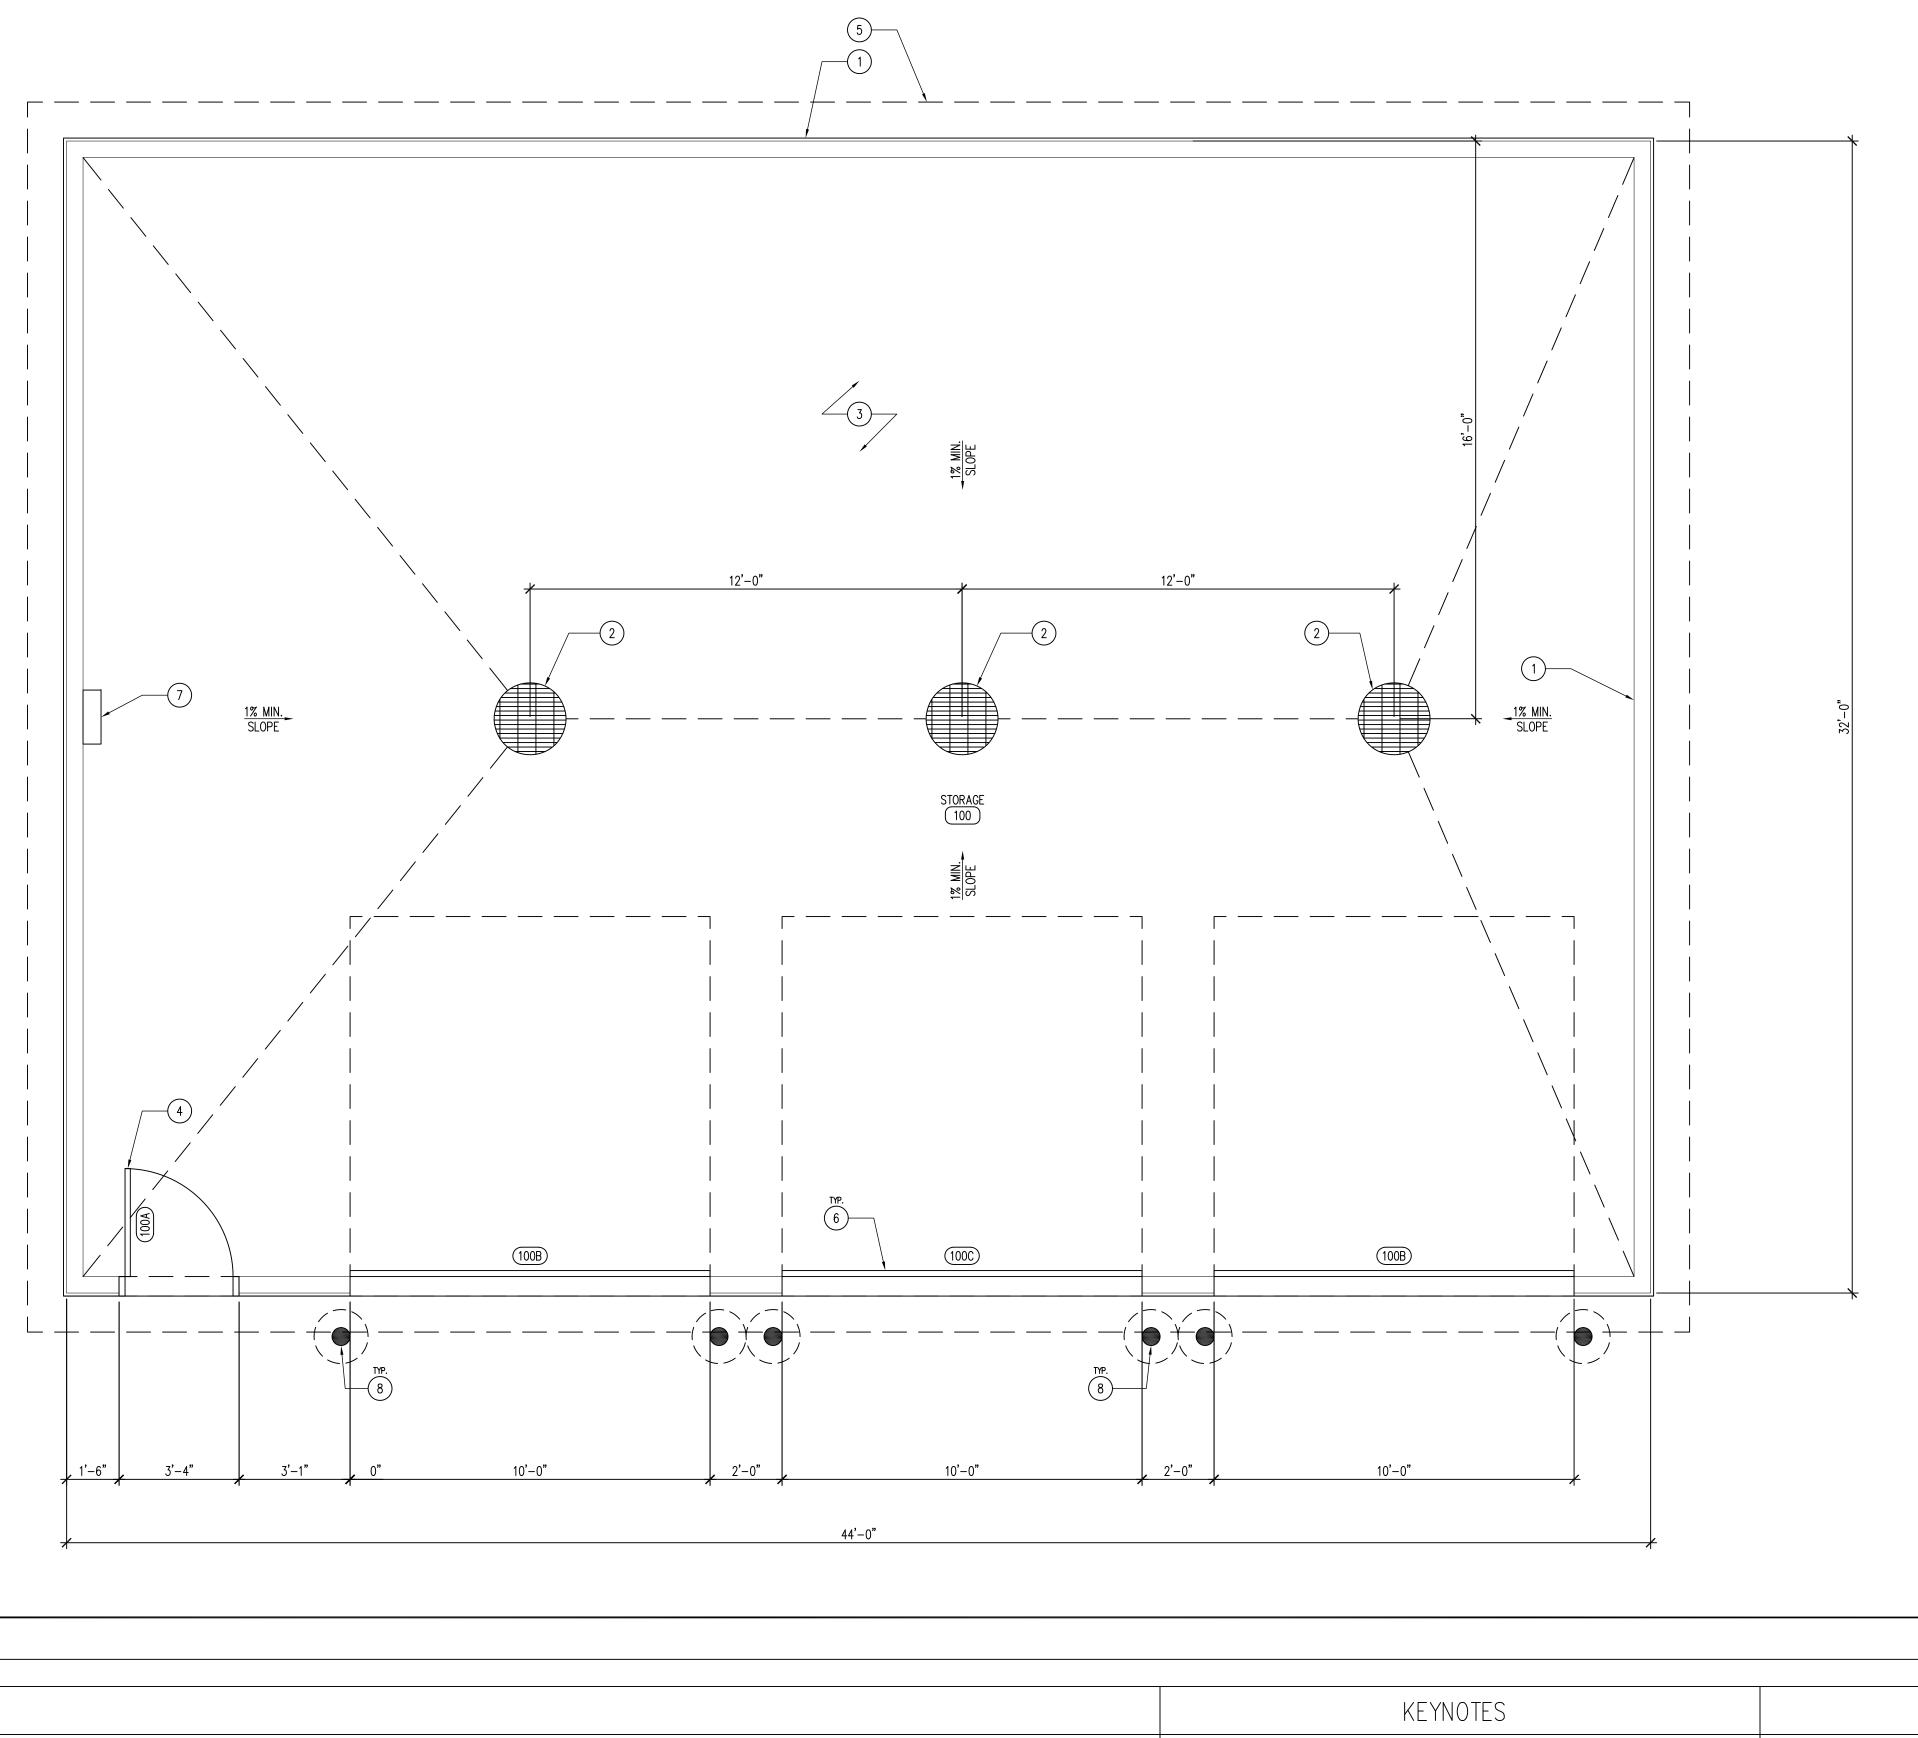
LIFE SAFETY PLAN AHQUABI STATE P

NO. BY REVISION

DRAWN BY: PROJECT NUMBER: 17-05-91-03

CHK'D BY: DATE: 03.01.2017

A-020



REFERENCE FLOOR PLAN

SCALE: 3/8" = 1'-0"

GENERAL NOTES 1. PROPOSED STORAGE BUILDING, POST-FRAME BUILDING WITH 26 GA MCELROY MAX-RIB ULTRA SIDING, A. REFER TO FINISH & DOOR SCHEDULE, SHEET A-600. B. ALL ELECTRICAL SHALL BE NEC COMPLIANT AND UP TO ALL CODES AND ORDINANCES REQUIRED BY 2. 24" DIAMETER X 48" DEEP ROUND DRAINAGE PIT, FILL WITH CLEAN CLASS A ROCK, COVER WITH CAST LAW. ALL OUTLETS TO BE MOUNTED AT 42" A.F.F. IRON GRATE, INSET IN CONCRETE WITH STEEL RIM, GRATE TO BE FLUSH WITH CONCRETE SLAB. C. REFER TO INDEX SHEET FOR WALL TYPES, SHEET A-002. D. FIELD VERIFY ALL DIMENSIONS PRIOR TO CONSTRUCTION, A-100.

E. FIELD VERIFY EQUIPMENT LOCATIONS FOR ELECTRICAL OUTLET LOCATIONS. REFER TO ELECTRICAL 3. 6" CONCRETE GARAGE SLAB WITH #4 REBAR 24" O.C. BOTH DIRECTIONS OVER 6" SUBBASE. SMOOTH TROWEL FLOOR FINISH, SLOPE FLOÖR, 1% MINIMUM, TO DRAINS AS SHOWN. 4. DOOR AS SCHEDULED, REFER TO SHEET A-600. F. REFER TO FINISH SCHEDULE SHEET FOR COLOR AND MATERIAL SECTIONS, SHEET A-600. 5. ROOF LINE ABOVE. G. CONTRACTOR TO HAVE THIS BUILDING, PRIOR TO CONSTRUCTION, PRE-ENGINEERED BY BUILDING 6. OVERHEAD GARAGE DOOR, CHI 3242. TRIM AROUND DOOR TO MATCH ROOF COLOR. REFER TO DOOR SCHEDULE SHEET A-600. SUPPLIER. 7. 100 AMP ELECTRICAL SERVICE PANEL, REFER TO SHEET A-110. 8. STEEL TRAFFIC BOLLARDS WITH BROWN PLASTIC PROTECTION SLEEVES, REFER TO DETAIL 02/A-200.

IOWA DEPARTMENT OF
NATURAL RESOURCES
ENGINEERING SERVICES - WALLACE BUILING

BUILDING FOR:
TATE PARK

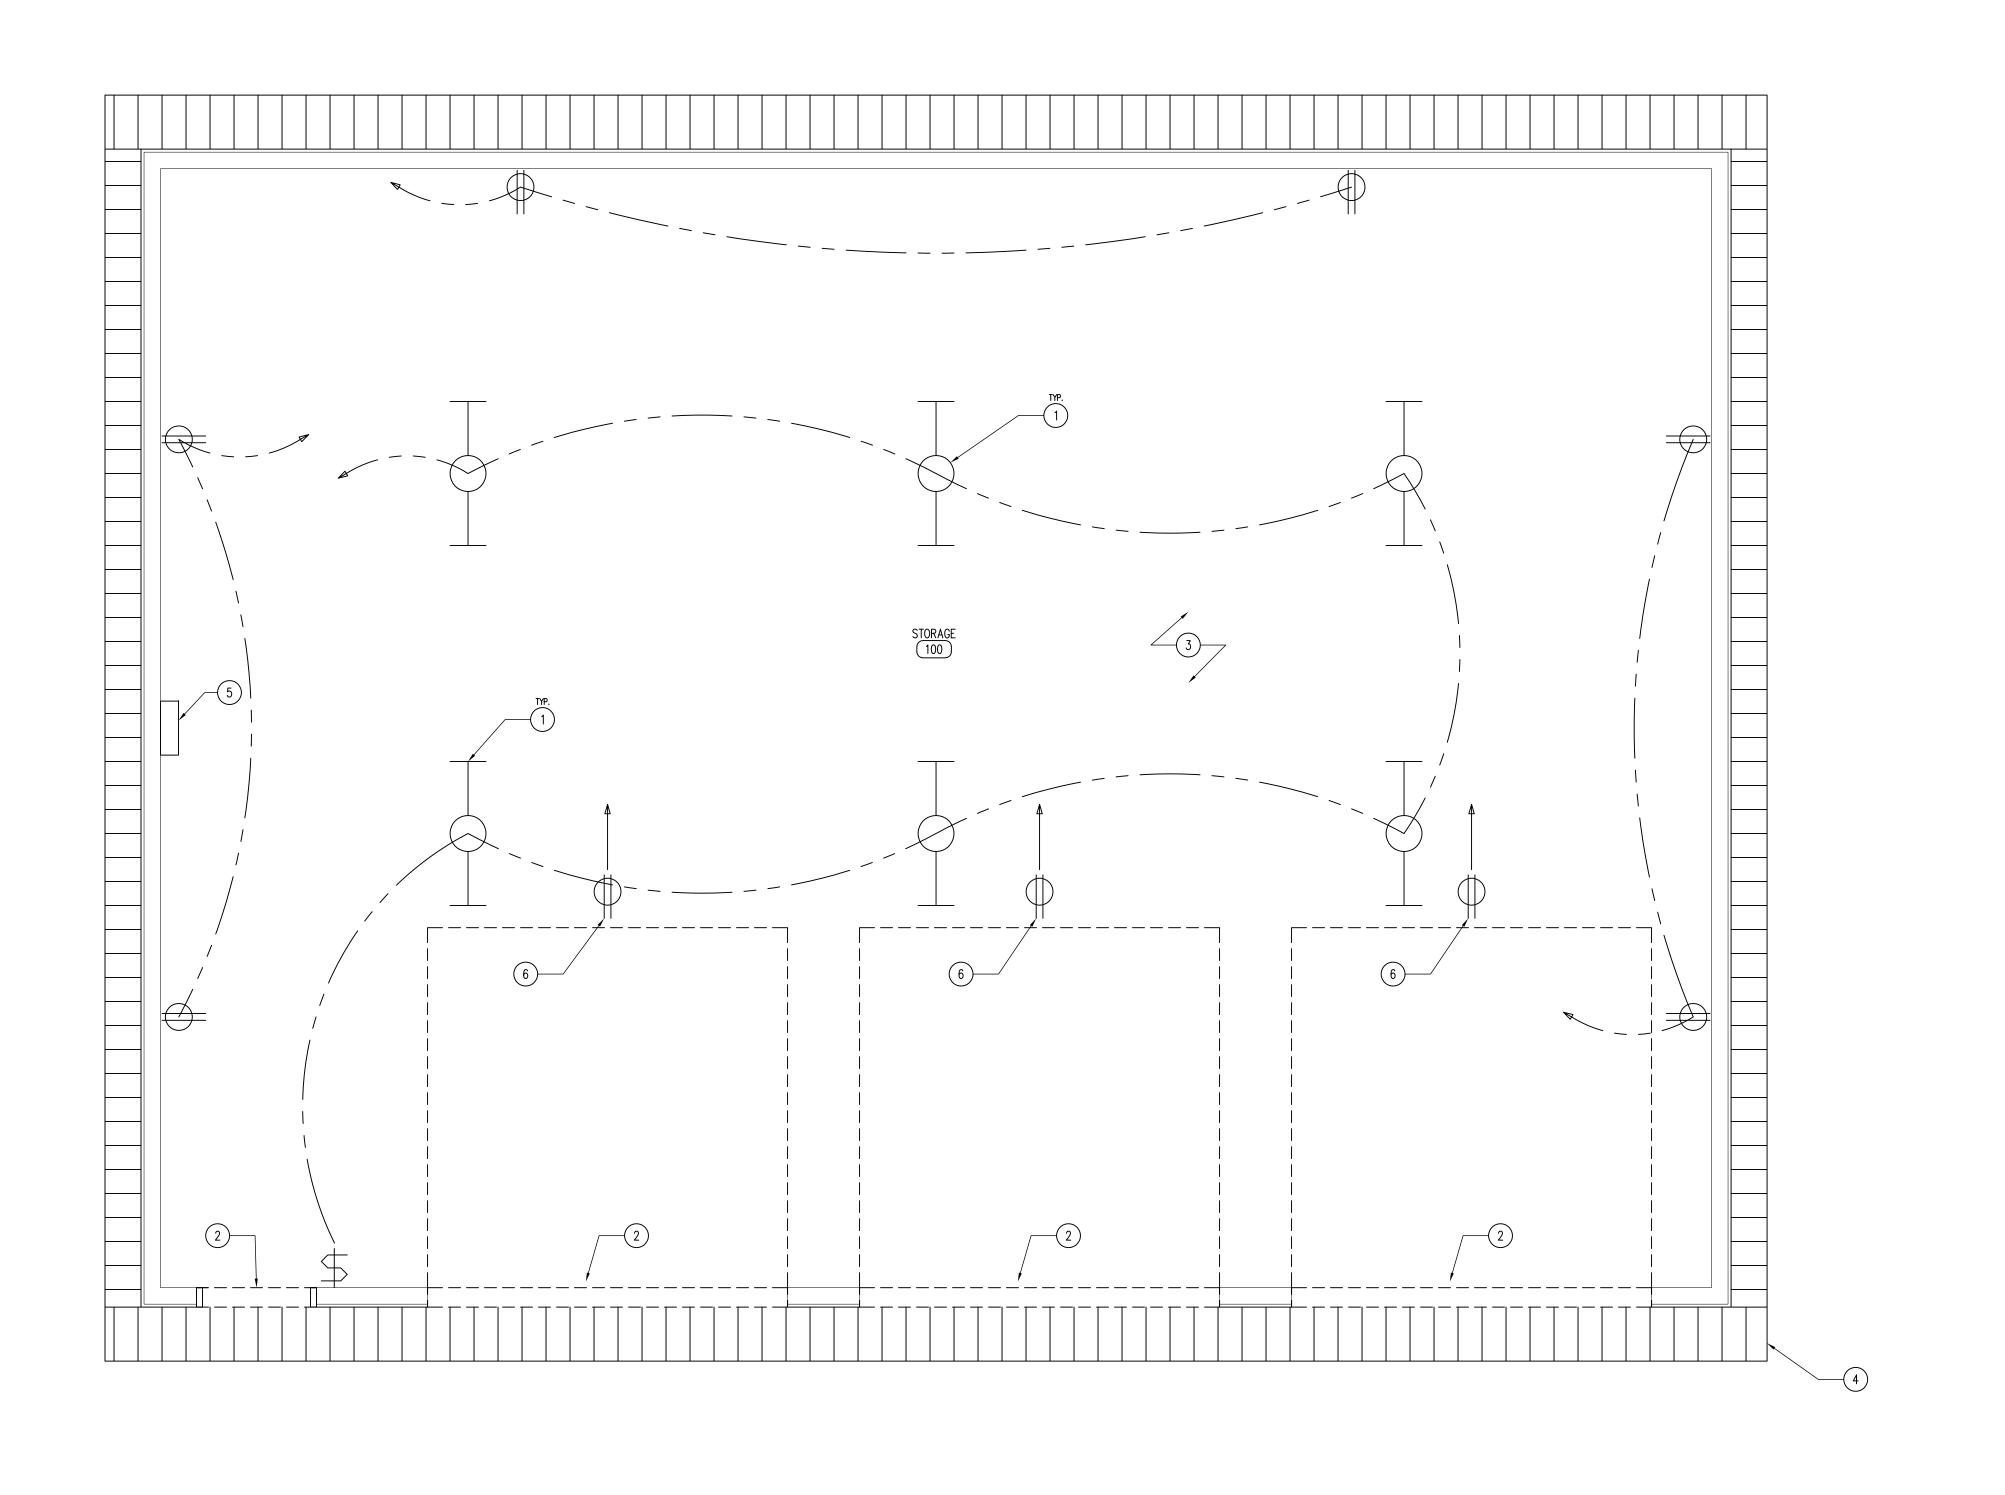
REFERENCE FLOOR
BOAT STORAGE BUILDING FOR:
AHQUABI STATE F

NO. BY REVISION

DRAWN BY: PROJECT NUMBER: 17-05-91-03

CHK'D BY: DATE: 02-01-7

03.01.2017
SHEET NO: **A-100**



O1 REFLECTED CEILING AND POWER PLAN SCALE: 3/8" = 1'-0"

ELECTRICAL LEGEND	LIGHTING LEGEND	KEYNOTES	GENERAL NOTES
→ BACK TO PANEL – ON SINGLE BREAKER 100 AMP SERVICE PANEL – COMPLY WITH ALL NEC CODE REQUIREMENTS	2 X 4 FLUORESCENT LIGHT FIXTURE: 4 LAMP, 32 WATT, LITHONIA AF10432 \$ SINGLE-POLE LIGHT SWITCH	 ELECTRICAL LIGHT FIXTURE. REFER TO ELECTRICAL DRAWINGS FOR FIXTURE SPECIFICATIONS AND POWER REQUIREMENTS. DOOR HEADER BELOW. NO CEILING - OPEN TO STRUCTURE ABOVE. FLUSH SOFFIT PANELS TO MATCH STANDING SEAM METAL ROOF. 100 AMP BREAKER PANEL. GARAGE DOOR OUTLET. 	 A. REFER TO FINISH & DOOR SCHEDULE, SHEET A-600. B. ALL ELECTRICAL SHALL BE NEC COMPLIANT AND UP TO ALL CODES AND ORDINANCES REQUIRED BY LAW. ALL OUTLETS TO BE MOUNTED AT 42" A.F.F. C. REFER TO INDEX SHEET FOR WALL TYPES, SHEET A-002. D. FIELD VERIFY ALL DIMENSIONS PRIOR TO CONSTRUCTION, A-100. E. FIELD VERIFY EQUIPMENT LOCATIONS FOR ELECTRICAL OUTLET LOCATIONS. REFER TO ELECTRICAL PLANS. F. REFER TO FINISH SCHEDULE SHEET FOR COLOR AND MATERIAL SECTIONS, SHEET A-600. G. CONTRACTOR TO HAVE THIS BUILDING, PRIOR TO CONSTRUCTION, PRE-ENGINEERED BY BUILDING SUPPLIER.



AHQUABI STATE

REFLECTED CEILING

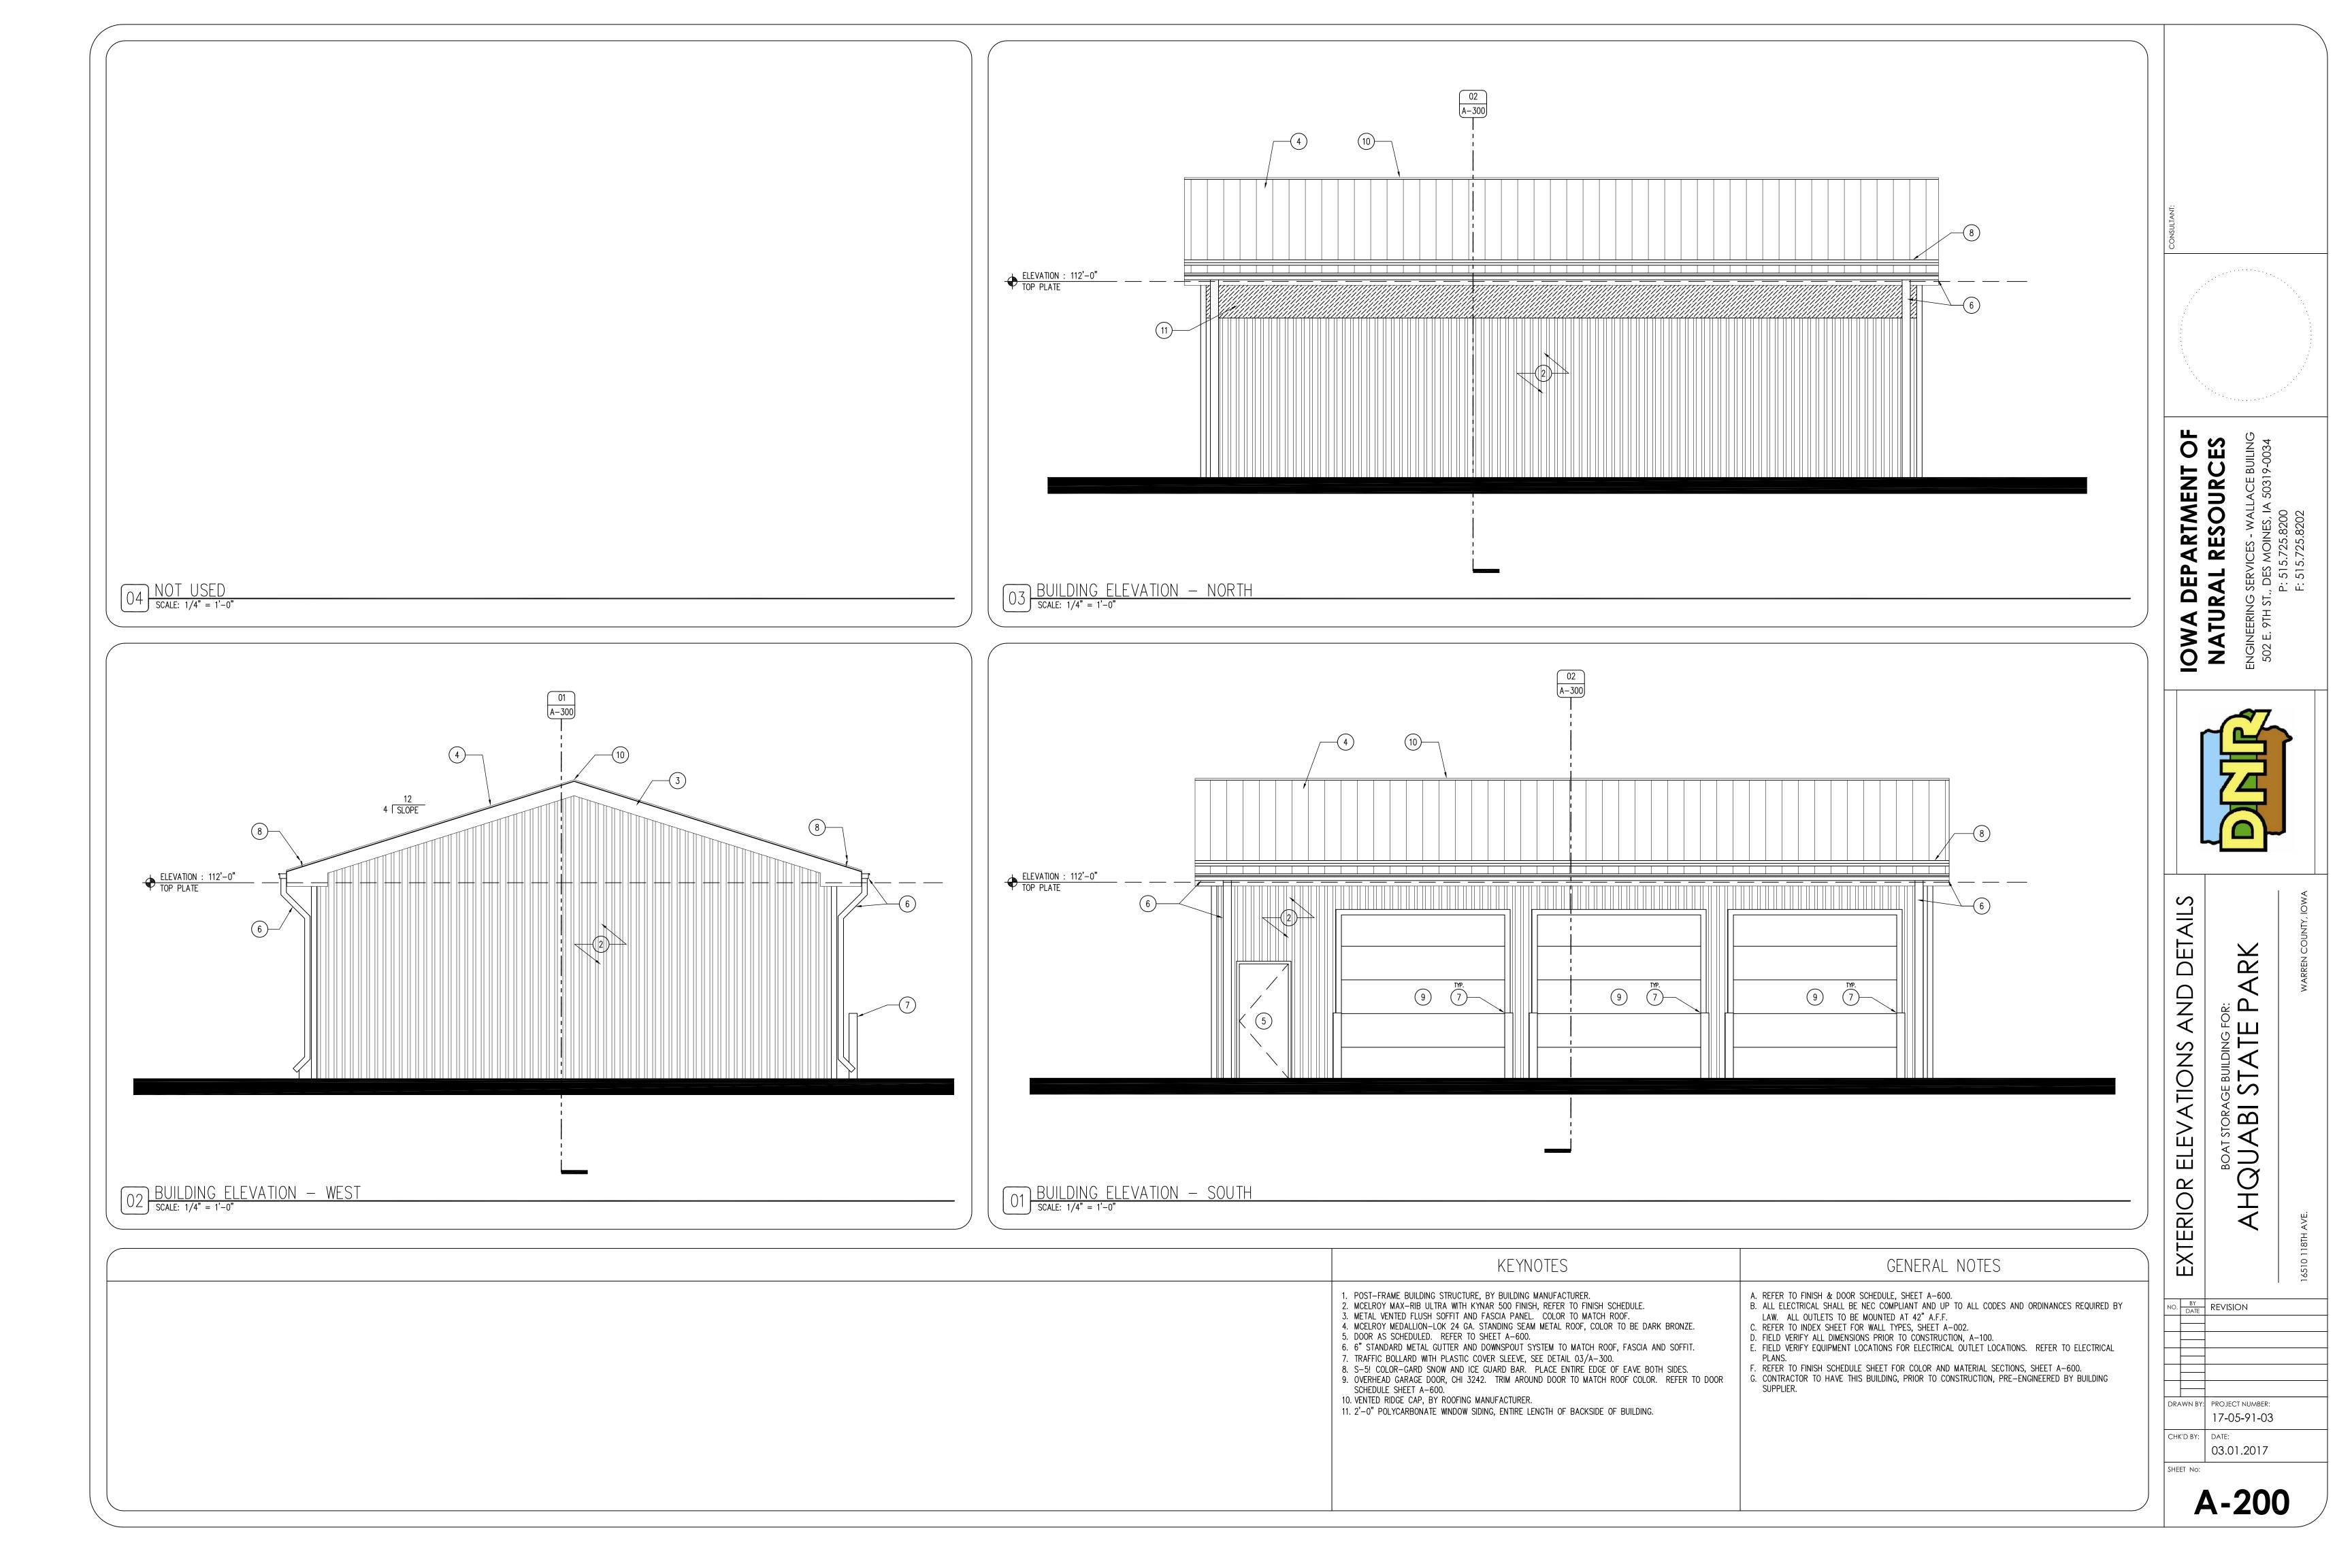
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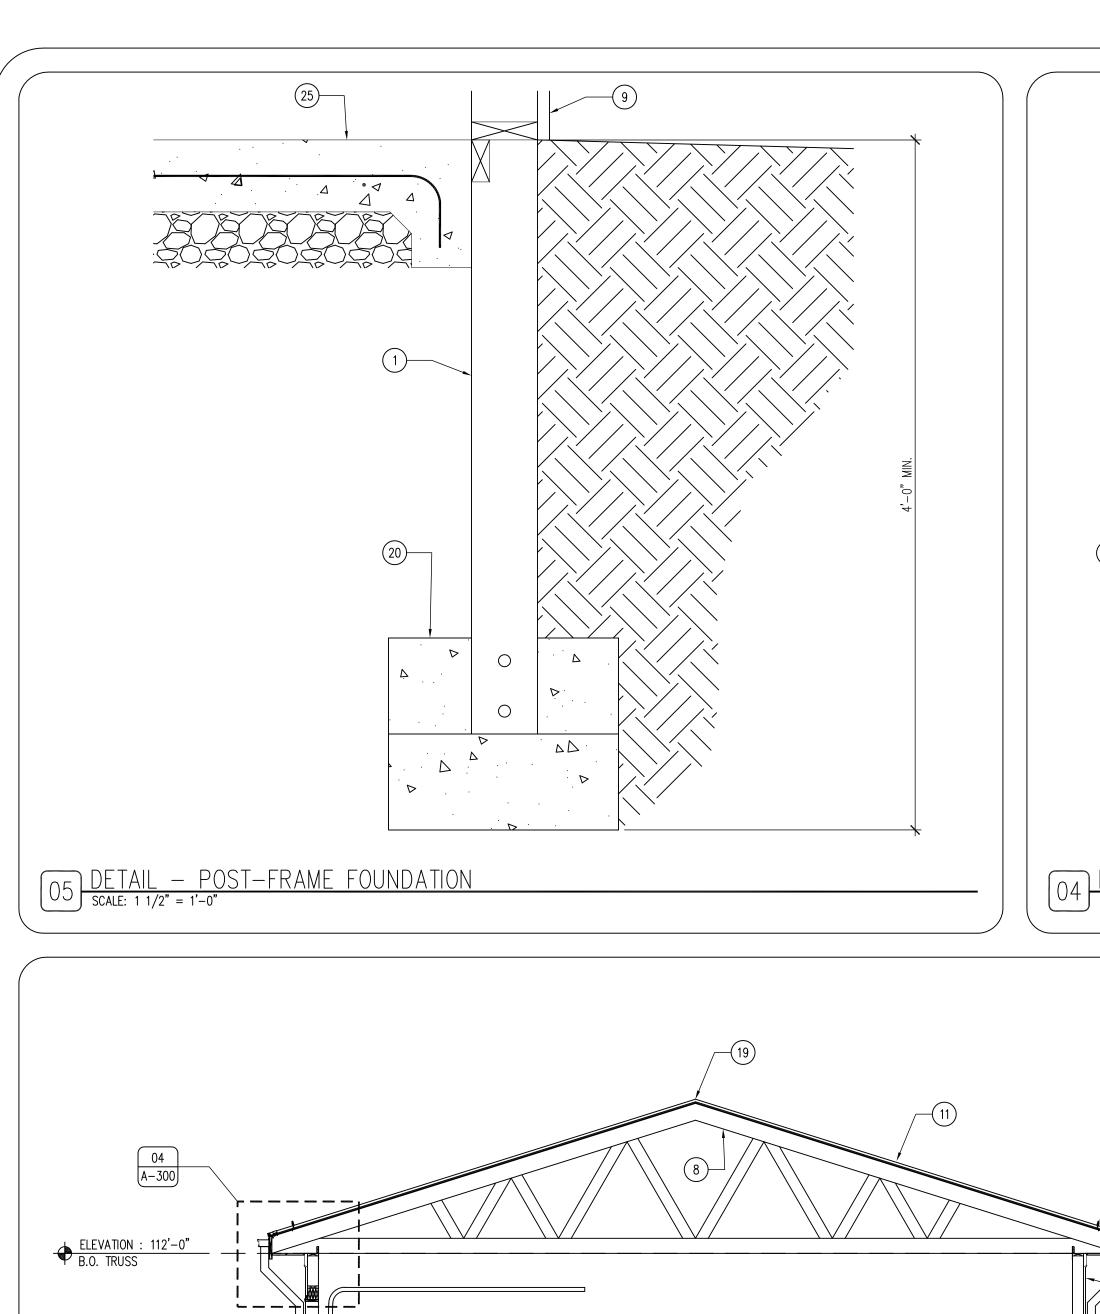
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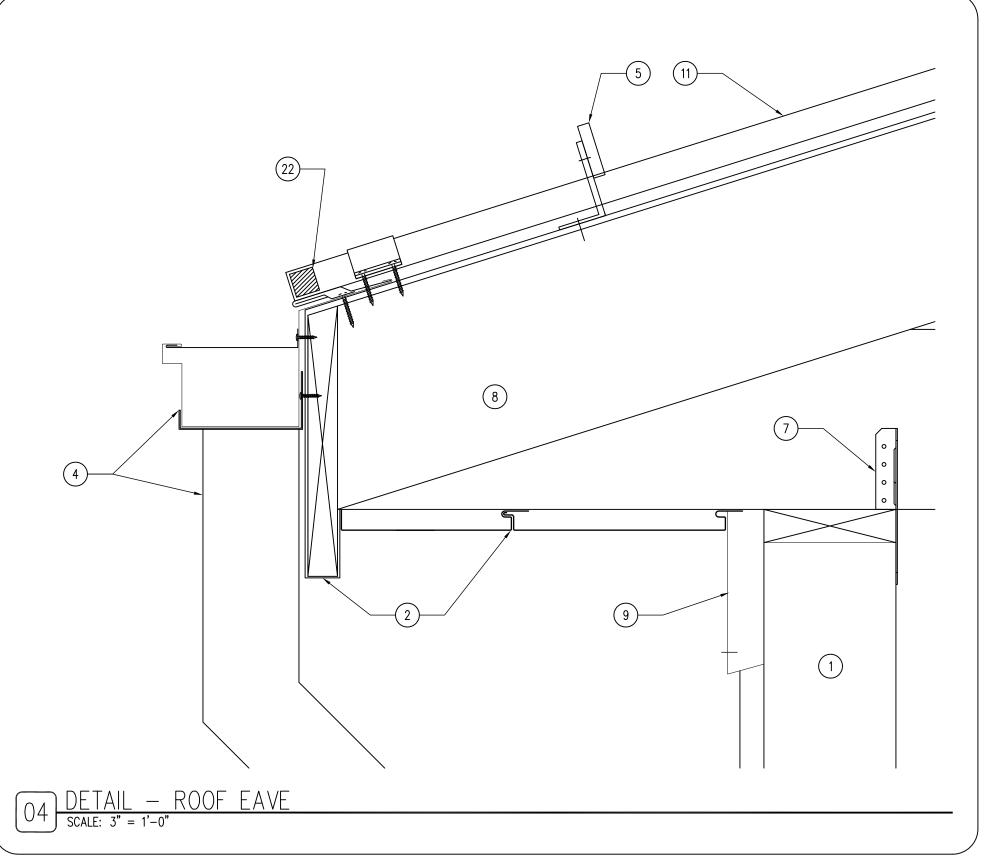
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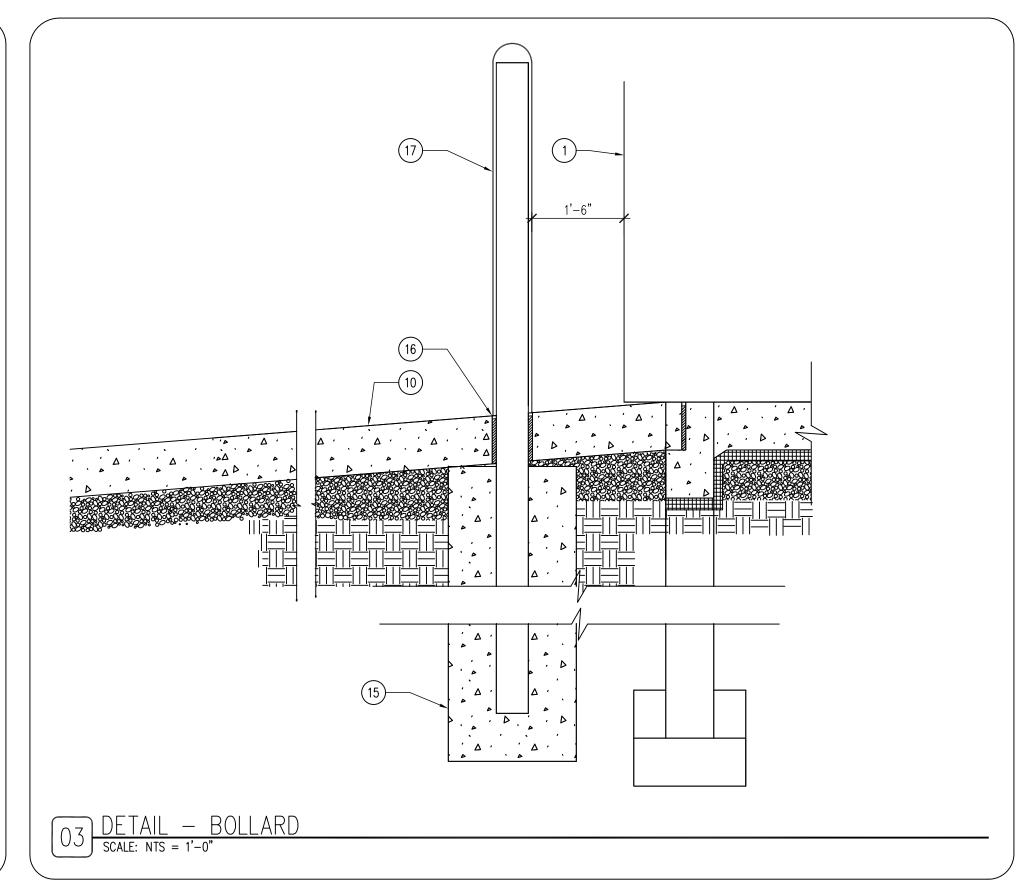
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03.01.2017

